

Design Review Report – Item 1

Local City of Stirling

government:

Item 1 – DA21/1210 – 373 Wanneroo Road, Balcatta – Development Assessment Panel Item no.:

- Form 1 - Child Care Premises

Emma Williamson Chairperson:

Panel Tony Blackwell (via Teams)

Lisa Shine members:

> Michael Murphy Stephen Carrick

Giovanna Lumbaca **Coordinator Planning** Local Cameron Howell Senior Planning Officer government

Planning Officer Michael Italiano officers: Simone Palmer **DRP Support Officer**

Observers

Date: 21 July 2022 Time: 2pm

City of Stirling - Challenger Room Venue:

Proponent/s	
Alan Stewart	Lateral Planning (Applicant)
Frank Macri	Macri Builders
Nicole Cavanagh	Plan E
Owners	Skinner Property Holdings Pty I td

Observer/s

Briefings							
Development assessment overview	Cameron Howell	Senior Planning Officer					
Technical issues	Cameron Howell	Senior Planning Officer					
Design Review							
Proposed development	Item 1 – DA21/1210 – 373 Wanneroo Road, Balcatta – Development Assessment Panel – Form 1 – Child Care Premises						
Property address	373 Wanneroo Road, B	373 Wanneroo Road, Balcatta					
Background							
Proposal							
Applicant or applicant's representative address to the design review panel	Alan Stewart Lateral Planning						
Key issues / recommendations	The Panel do not support the current proposal as it fails to address its context as an important corner site. The building form needs to be significantly improved to create a strong, articulated edge that responds to						



	issues of orientation and safety as well as the character of the place.
	The material palette of the proposal, along with the articulation of the facades is lacking and the Panel do not believe this will be a positive contribution to this developing location.
	Refer to attached Design Quality Evaluation Report.
Chairperson signature	Frams Myss

Design quality eva	aluation 0 – 373 Wanneroo Road Balcatta – DAP – Form 1 – Childcare Premises
	ursday 21 July 2022
	Design Principle satisfied
	Design Principle pending further attention
	Design Principle not satisfied
Principle 1 Context and character	Good design responds to and enhances the distinctive characteristics of a local area, contributing to a sense of place.
	1a. The Panel commented on the significance of the corner site and the need to strengthen the building to respond to this. The current building form does not adequately respond to the corner context and is not supported.
	1b. The Panel emphasized the need for the design to respond to its context and to look for characteristics of the local area. This has not been adequately addressed.
	1c. The Panel recommended the Applicant apply further thought and interrogation in relation to the context and character of the development, including what the future context of the area might be.
	1d. The Panel does not support and expressed concern in relation to the use of the red brick as this is not considered to be a response to the context.
	The Panel strongly encouraged the Applicant to look at the area and take cues from the immediate vicinity.
Principle 2 Landscape quality	Good design recognises that together landscape and buildings operate as an integrated and sustainable system, within a broader ecological context.
	2a. The Panel commended the Applicant on the addition of a landscape architect and stated this has contributed positively to the design.
	2b. The Panel noted that space in the car park for the trees remains compromised.
	2c. The Panel requested clarification via drawings in relation to the installation technique used for the synthetic turf that the Applicant claim alleviates most of the heat.
	2d. The Panel noted the heavy reliance on the upper deck for landscaping. Concern was expressed around the size of the planter boxes and pots for the nominated tree species.
	2e. It was mentioned by the Panel the site planning is problematic which causes issues in relation to the landscaping of the ground level.
	2f. The Panel commented that the experience of the carpark, as the primary entry experience for many, could be improved by improvements to the hardscape to indicate the shared nature of the space.
Principle 3 Built form and scale	Good design ensures that the massing and height of development is appropriate to its setting and successfully negotiates between existing built form and the intended future character of the local area.
	3a. The Panel stated they do not support the built form and massing of the building as it fails to adequately address the corner.
	3b. It was stated by the Panel there is a lack of shading and suggested the addition of shading devices to the windows. These elements will have a significant impact on the bulk of the building as well as the aesthetics. A further review of the building would be required to assess the impact of these on the design.
Principle 4 Functionality and build quality	Good design meets the needs of users efficiently and effectively, balancing functional requirements to perform well and deliver optimum benefit over the full life-cycle.
-	4a. The Panel commented on the covered walkway on the upper floor suggesting it may be beneficial to consider simplifying this in the area outside Activity Room

	4 to deepen and become a sheltered play area.
	4b. The Panel stated functionality has improved overall.
	15. The Farier stated farietismanty has improved everall.
Principle 5 Sustainability	Good design optimises the sustainability of the built environment, delivering positive environmental, social and economic outcomes.
	 5a. The Applicant was encouraged to move from generic opportunities to incorporate sustainability and make a strong and ambitious commitments to this design principle. 5b. The Panel requested a copy of the sustainability report which was provided after the meeting. The Panel commented following this reading that the document lacks commitment and talks about targets rather than commitments.
	5c. There was concern shown by the Panel around the lack of shading to openings. This will have a significant impact on the comfort and energy consumption of many spaces.
	5d. The Panel support the inclusion of openable windows and operable skylights for cross ventilation.
	5e. Comment was made by the Panel that photovoltaic cells are shown as indicative only on the roof and further clarity is requested in addition to a commitment that these form part of the proposal.
	5f. A solar analysis report, indicating solar access and shading, was requested by the Panel.
Principle 6	Good design optimises internal and external amenity for occupants, visitors and
Amenity	neighbours providing environments that are comfortable, productive and healthy.
	6a. There has been an improvement with the amenity of this proposal, and it is now supported by the Panel.
Principle 7 Legibility	Good design results in buildings and places that are legible, with clear connections and easily identifiable elements to help people find their way around
	 7a. The Panel stated it is good to have the signage close to the entry. 7b. It was mentioned by the Panel the legibility of the entry feels compressed. There could be an opportunity to improve the arrival experience.
Principle 8 Safety	Good design optimises safety and security, minimising the risk of personal harm and supporting safe behaviour and use.
	8a. The Panel commented that the implementation of crash barriers on the corner should be considered and integrated into the design at this stage. The craft room is located at the corner and the Panel expressed concern in relation to the safety of children in this space if an accident was to occur.
Principle 9 Community	Good design responds to local community needs as well as the wider social context, providing environments that support a diverse range of people and facilitate social interaction.
	9a. This design principle is supported by the Panel.
Principle 10 Aesthetics	Good design is the product of a skilled, judicious design process that results in attractiveand inviting buildings and places that engage the senses.
	10a. The Panel expressed support for the reduced setbacks as they reinforce the street edge.
	10b. The Panel do not support the current language of the building stating that it is generic in nature and does not read as a childcare center.
	10b. Comment was made by the Panel the minimal material palette; lack of shading elements and lack of articulation generally have resulted in a bland building.

- 10d. The Panel stated it is important to think about the building users and create an environment that has tactility and suggested working towards creating an environment that is inviting. This can be achieved through a carefully considered material palette as well as the composition of the form.
- 10e. The Panel noted the applicants move to minimize the view of the under slab services from the street and support this. The primary arrival experience of many will be via the carpark and the applicant is encouraged to consider ways in which these services could be further minimized either through paint or a soffit.
- 10f. The Panel expressed their concern in relation to the use of glass balustrading, noting that this may not be functional in terms of cleaning as well as failing to provide filtered views into and out of the facility. Alternative materials such as perforated, painted steel should be explored.

Design Review progress Item 1 – DA21/1210 – 373 Wanneroo Road Balcatta – DAP – Form 1 – Childcare Premises DRP Meeting – Thursday 21 July 2022						
Design Principle satisfied						
Design Principle pending further attention						
Design Principle not satisfied						
	DR1 5/8/2022	DR2 3/3/2022	DR3 21/7/2022			
Principle 1 - Context and character						
Principle 2 - Landscape quality						
Principle 3 - Built form and scale						
Principle 4 - Functionality and build quality						
Principle 5 - Sustainability						
Principle 6 - Amenity						
Principle 7 - Legibility						
Principle 8 - Safety						
Principle 9 - Community						
Principle 10 - Aesthetics						

Recommendations Summ				
DR1 – DRP Recommendations DRP Meeting – 5/8/2021	DR1 – Applicant Response DRP Meeting – 5/8/2021	DR2 DRP Recommendations DRP Meeting – 3/3/2022	ecommendations DRP Meeting – 3/3/2022	
 1b. Comment was made by the Panel that observing the future intended character of the local area is important. 1c. Comment was made when developing the design, the materiality should be considered and in addition what the context can contribute to the project. 1d. The Panel stated there is insufficient analysis on the context and requests further analysis at the next meeting. 1e. The Panel suggested looking more closely at the context of the surrounding streets and incorporating this into the design. 1f. The Panel noted the building location is close to the nilboundary setback stipulated in the Activity Centre planning scheme, 	Painted rendered masonry walls. Pitched tile roof Pitched aluminium roof Feature brick Gable roof	 1a. The Panel commented they appreciate the effort to provide the existing context and character analysis and seek clarification in regard to the ways in which this relates to the design. 1b. The Panel requested further thought around the future context of the area. 	1 The building utilises a combination of painted masonry and face brick walls, consistent with the prevailing building materials in the locality. The future context of the area is likely to see existing one to two storey buildings replaced with medium density housing of two to three storeys, stepping up to six storey mixed use development within the Northlands District Centre. The proposed building height represents an appropriate transition of scale between the existing scale of development in the area and the opportunity for taller buildings in the District Centre. The Child Care Centre is orientated toward Amelia Street with a reduced setback to both street frontages and a high level of façade articulation and fenestration to enhance the streetscape and emphasise the site's corner location.	 1c. The Panel recommended the Applicant apply further thought and interrogation in relation to the context and character of the development, including what the future context of the area might be. 1e. The Panel strongly encouraged the Applicant to look at the area and take cues from the immediate vicinity.

hut considers the			1		1	
but considers the						
building form needs						
to be much more						
cohesive.						
2a. The Panel stated the	2a.	The Panel	2.	A landscape architect has	2c.	The Panel requested
landscaping does not		recommended		been engaged to prepare a		clarification via drawings
respond to the		engaging the services		new Landscape Concept for		in relation to the
building design		of a landscape		the site.		installation technique
circulation layout.		architect to assist with		Careful consideration has		used for the synthetic turf
2b. There is opportunity		improvements to the		been given to the design of		that the Applicant claim
to increase deep soil		landscape quality.		the landscaping, with soft		alleviates most of the
planting and add a	2b.	The Panel suggested		landscaped edges proposed		heat.
large tree by moving		making landscaping a		to the site boundaries and	2f.	The Panel commented
the fire escape stairs		priority, ensuring this		tree planting in-ground and		that the experience of the
to another location on		is integrated in a		on-structure. Three advanced		carpark, as the primary
the other side.		landscape and		trees are proposed at ground		entry experience for
2c. Comment was made		architecture		level to soften the appearance		many, could be improved
by the Panel the		response, instead of		of the building from abutting		by improvements to the
landscaping feels		landscape existing in		properties, with small to		hardscape to indicate the
underwhelming and		largely left over		medium sized trees also		shared nature of the
there is opportunity		space.		proposed.		space.
for improvement and	2c.	The Panel questioned		The amount of soft		Sport St.
to create a buffer to		whether the 10%		landscaping provided at		
Wanneroo Road.		deep soil calculations		ground level is approximately		
2d. The Panel noted		include undercover		60 square metres, which		
more planting could		areas and seek		includes uncovered, in-		
be incorporated into		clarification of the		ground planting areas only. In		
the parking area.		calculations.		addition:		
the parking area.	2d.	There was comment		 20 square metres of 		
	20.	made by the Panel		planting in structure is		
		there is a heavy		proposed on the first floor		
		reliance on shade		External Play Area;		
		sails on the upper		3 Advanced Trees with		
		deck and suggested				
		that an integrated		strata cells of 9 square metres are proposed at		
		<u> </u>		Ground level;		
		approach with the		Ground level;7 small / medium sized		
		architecture could				
	24	improve the design.		trees are proposed at		
	2f.	The Applicant was		ground level;		
		encouraged to		8 small trees in planters		
		provide further		are proposed in the first		

	2g.	thought around the number of plant species as the number of varieties is very low. It was suggested by the Panel it would benefit the proposal to apply further thought and development around the hardscape.		floor External Play Area; and Landscaping is proposed to the verge between the site boundary and footpath. Shade is provided through a combination of shade sails, an arbor structure with climbing plants, trees (in ground and in pots), with individual areas of synthetic turf reduced in size and separated by decking / paving. The landscape design and approach, including play equipment, decking, shade structures and planting, is consistent with that taken at other centres managed by the operator of the proposed premises. A species palette is provided in the Landscape Plan.		
3b. The Panel stated the built form requires further thought and consideration. 3c. The Panel commented the planning is compromised and there are too many elements. 3d. The Panel suggested further thought be given to balancing pedestrian movement space between the inside and outside.	3a. 3b.	The Panel requested further clarification and information on the heights of the walls and fences. It was suggested by the Panel it would be beneficial to consider the corner composition as one elevation. This could be achieved by unwrapping the elevation on two sides to create one elevation for cohesive	3.	Wall and fence heights are shown on the drawings and described in our letter dated 4 July 2022. Boundary retaining, fencing and walls vary in height from approximately 1.8 metres to 3 metres depending on the context and requirement for visual and acoustic screening. The majority of boundary walls / fences abut the driveways of the adjacent properties, with the exception of the bin store wall which is only 1.8 metres in height.	3a. 3b.	The Panel stated they do not support the built form and massing of the building as it fails to adequately address the corner. It was stated by the Panel there is a lack of shading and suggested the addition of shading devices to the windows. These elements will have a significant impact on the bulk of the building as well as the aesthetics. A further review of the
3e. Concern was expressed by the	3c.	design. It was recommended		With respect to the walls of the building, the majority of		building would be required to assess the

						1	
Panel around the			the Applicant think		walls satisfy the maximum		impact of these on the
variety of shapes and			about the building		height of 7 metres, with only		design.
forms which creates			turning the corner		minor elements protruding		
an overly busy plan			and potential		above a height of 7 metres		
and building form.			improvements that		generally where skillion roof		
			might be made by		elements are proposed.		
			increasing the height		The façade of the building has		
			of the corner element.		been refined to reduce the		
					number of distinct elements		
					and create a more continuous		
					and consistent edge to the		
					street. The curved corner		
					element has been increased		
					in height to emphasise the		
					corner.		
					The Landscape Plan depicts		
					the proposed finished		
					treatment of the External Play		
					Area on the upper level while		
					a three-dimensional		
					perspective depicts the		
					proposed design and finishes		
					of the upper level elevations		
					facing the External Play Area.		
					The façade of the building has been refined to reduce the		
					number of distinct elements		
					and create a more continuous		
					and consistent edge to the		
					street. The curved corner		
					element has been increased		
					in height to emphasise the		
				_	corner.	<u> </u>	
4a. The Panel stated the	4a. Enlarged entry	4c.	The Panel	4.	A generously-sized pedestrian	4a.	The Panel commented
tightness and	portico		recommended the		portico is provided external to		on the covered walkway
congestion at the	4b. Stairs reorientated		reception desk and		the entry foyer. The entry		on the upper floor
entry zone is	4c. Enlarged entry		administration area		foyer is spacious and a built-in		suggesting it may be
problematic.	portico		should be visible from		signing in desk is shown on		beneficial to consider
4b. Suggestion was made	4d. Revised carpark		the staff areas.		the drawings.		simplifying this in the
by the Panel that	design	4d.	It was stated by the		The centre manager will be		area outside Activity
reorientation of the	4e. Services relocated		Panel the location of		located in the office abutting		Room 4 to deepen and

			1	
stairs could allow a more generous space around the entry point and foyer. 4c. There was comment made the north facing activity rooms are unshaded and may require protection. 4d. The Panel commented the openness of the carpark on the street is functional but there may be opportunity to gate or screen some of the carpark. 4e. Comment was made by the Panel there is opportunity to strategize around concealing the services that will be below the first floor play deck. 4f. The Panel noted the shape of the ground floor play area makes supervision difficult.	4f. Ground floor external play area revised.	the air conditioning stores may block natural light into the activity room and requires further interrogation.	the entry foyer. The office is provided with glazing for clear line of sight to the foyer, portico and footpath. The air conditioning store is located in the car park, at the rear of the building, under the upper level External Play Area. Activity Room 1 is provided with glazing to the ground floor External Play Area and the design has been modified to remove the full height internal wall between Activity Room 1 and the Nappy Change room, to further improve natural daylight. The multi-purpose space has been deleted due to the design changes made to the building.	become a sheltered play area.
 5a. The Panel noted this principle has not been adequately addressed and there is opportunity for further thought and development. 5b. Comment was made the north facing windows are fixed and not appropriate for cross ventilation. 	5. Revised first floor activity rooms.	 5a. The Panel stated the sustainability principle is underdeveloped and requires further thought. 5b. The Applicant was encouraged by the Panel to make a commitment to sustainability and provide further information in the way 	5. A Sustainable Design Report has been commissioned, which addresses indoor environmental quality, energy (including solar shading analysis and solar PVC's), water and stormwater, building materials, transport and waste. Roof-mounted solar panels have been provided	 5a. The Applicant was encouraged to move from generic opportunities to incorporate sustainability and make a strong and ambitious commitments to this design principle. 5b. The Panel requested a copy of the sustainability report which was provided after the

5c. The Panel encouraged the Applicant to make a commitment to sustainability. 5d. The Panel suggested incorporating recycled asphalt which would reduce the environmental impact and improve sustainability. 5e. It was suggested by the Panel to give further thought and consideration to the west facing unprotected glazing.		5d.	of a sustainability strategy. Solar HWS, photovoltaic cells and rainwater harvesting were some of the options suggested to improve sustainability. The Panel requested further information to permit a better understanding in relation to natural ventilation.		and the car park will utilise recycled bitumen paving. A covered deck for shade is proposed to the north side of the upper level Activity Rooms, while a combination of structures, sails and trees will provide shade to the External Play Area. Operable skylights have been added to the upper level Activity Rooms to improve daylight and ventilation. Activity Room 1 is provided with glazing to the ground floor External Play Area and the design has been modified to remove the full height internal wall between Activity Room 1 and the Nappy Change room, to further improve natural daylight.	5e.	meeting. The Panel commented following this reading that the document lacks commitment and talks about targets rather than commitments. Comment was made by the Panel that photovoltaic cells are shown as indicative only on the roof and further clarity is requested in addition to a commitment that these form part of the proposal. A solar analysis report, indicating solar access and shading, was requested by the Panel.
 6c. The circulation is very tight and there is opportunity for further thought and development. 6d. The Panel believes there is opportunity to improve the quality of the play area equipment. 6e. Comment was made by the Panel the synthetic turf applied to the play areas would require shading. 	6d. Revised play equipment. 6e. Shade sails to first floor external play area.			6.	A landscape architect has been appointed to prepare a revised Landscape Plan to improve the design and amenity of the external play areas. A combination of structures, sails and trees will provide shade to the External Play Area, while a covered walkway is now proposed along the northern edge of the Activity Rooms and between the two building elements on the upper level.	6.	This principle is now supported.

 7b. The Panel stated the signage is not evident and requires further development. 7c. The Panel commented the hierarchy of the buildings is hard to read and requires further thought and development. 	signage is not evident and requires further development. The Panel commented the hierarchy of the buildings is hard to read and requires further thought and		It was suggested by the Panel there is opportunity to further improve the materiality of the entry zone to continue to develop the legibility of this element. It was recommended by the Panel to consider the link between the branding and materiality and question the overlap of signage on the timber feature element. The Panel suggested further integrating the branding and signage into the design.	7.	The front entry is clearly defined with an external portico, pacing connecting to the footpath and the awning with signage over the footpath. An example of the operators branding / signage is shown below. Signage is limited to the awning which is consistent with the operators preferred approach to create contemporary buildings that are not overly whimsical.	7b.	It was mentioned by the Panel the legibility of the entry feels compressed. There could be an opportunity to improve the arrival experience.
8a. There was comment made by the Panel the glass fence adjacent to the trafficable entry is potentially dangerous. 8b. The Panel commented there is a pinch point for pedestrians at the vehicle entry.	8a. Revised entry design.			8.	Details of species are provided in the Landscape Plan. High quality synthetic turf will be utilised, together with various shading devices, to reduce the risk of overheating in summer.	8a.	The Panel commented that the implementation of crash barriers on the corner should be considered and integrated into the design at this stage. The craft room is located at the corner and the Panel expressed concern in relation to the safety of children in this space if an accident was to occur.
10a. The Panel commented the form and aesthetics of the	10. Revised design	10a.	The Panel commented the red brick feels like it is a	10.	The building utilises a combination of painted masonry and face brick,	10d.	The Panel stated it is important to think about the building users and

building is lacking		remnant of the	together with timber		create an environment
cohesion.		previous design and	cladding elements,		that has tactility and
10b. The Panel		recommended	consistent with the		suggested working
requested more		revisiting the	operators preferred		towards creating an
information on what		material palette to	branding.		environment that is
would be visible		ensure a cohesive	The façade has been		inviting. This can be
from the street		and curated	refined to reduce the		achieved through a
above and below the		selection.	number of competing		carefully considered
play deck at the car	10b.	The Panel	elements and create a		material palette as well as
park entry.		commented on the	continuous edge to the		the composition of the
10c. The Panel believes		current composition	street. The curved element		form.
the escape stair		of the building,	has been increased in	10e.	The Panel noted the
facing Wanneroo		noting that there are	height to emphasise the		applicants move to
Road detracts from		several competing	corner. The coloured		minimize the view of the
the street elevation.		elements.	squares have been deleted		under slab services from
		Development of this	with a more refined		the street and support
		should seek to	branding approach now		this. The primary arrival
		create a hierarchy,	proposed. Signage is		experience of many will
		ensuring that the	limited to the awning which		be via the carpark and
		corner is anchored,	is consistent with the		the applicant is
		and the elevation is	operators preferred		encouraged to consider
		seen as a whole.	approach to create		ways in which these
	10c.	The Panel sought	contemporary buildings		services could be further
		clarification in	that are not overly		minimized either through
		relation to the	whimsical.		paint or a soffit.
		coloured squares on	The front edge and	10f.	The Panel expressed
		the building,	underside of the slab will		their concern in relation
		suggesting that if	be carefully considered to		to the use of glass
		these are not part of	ensure services are		balustrading, noting that
		the branding they	concealed. Further details		this may not be functional
		might be	can be provided prior to		in terms of cleaning as
		reconsidered.	issue of a Building Permit.		well as failing to provide
	10d.	Comment was made			filtered views into and out
		by the Panel that the			of the facility. Alternative
		building does not yet			materials such as
		communicate it's			perforated, painted steel
		use as a childcare			should be explored.
		centre. This should			
		be addressed			
		through			
		consideration of the			

composition as well as the tactility of the materials used. 10e. The Panel commented on the importance of considering the underside of the slab and ensuring a design response responds to this.

Skinner Property Holdings Pty Ltd ATF Otranto Trust

Address:373 Wanneroo Road, Balcatta

Childcare Centre

Job Number: 21056

Drawing No		Description				
PD01		Cover Sheet				
	PD02	3D				
	PD03	3D				
PD04		Site Plans				
PD05		Context Plan				
	PD06	Ground Floor Plan				
	PD07	First Floor Plan				
	PD08	GF Site Overlay				
	PD09	FF Site Overlay				
	PD10	Elevations				
	PD11	Elevations				
	PD12	Roof Plan				
	PD13	Existing Tiny Beez Centres				











E: frank@macribuilders.com.au P: 9444 9829 M: 0407 727 766

©COPYRIGHT









E: frank@macribuilders.com.au P: 9444 9829

M: 0407 727 766

©COPYRIGHT

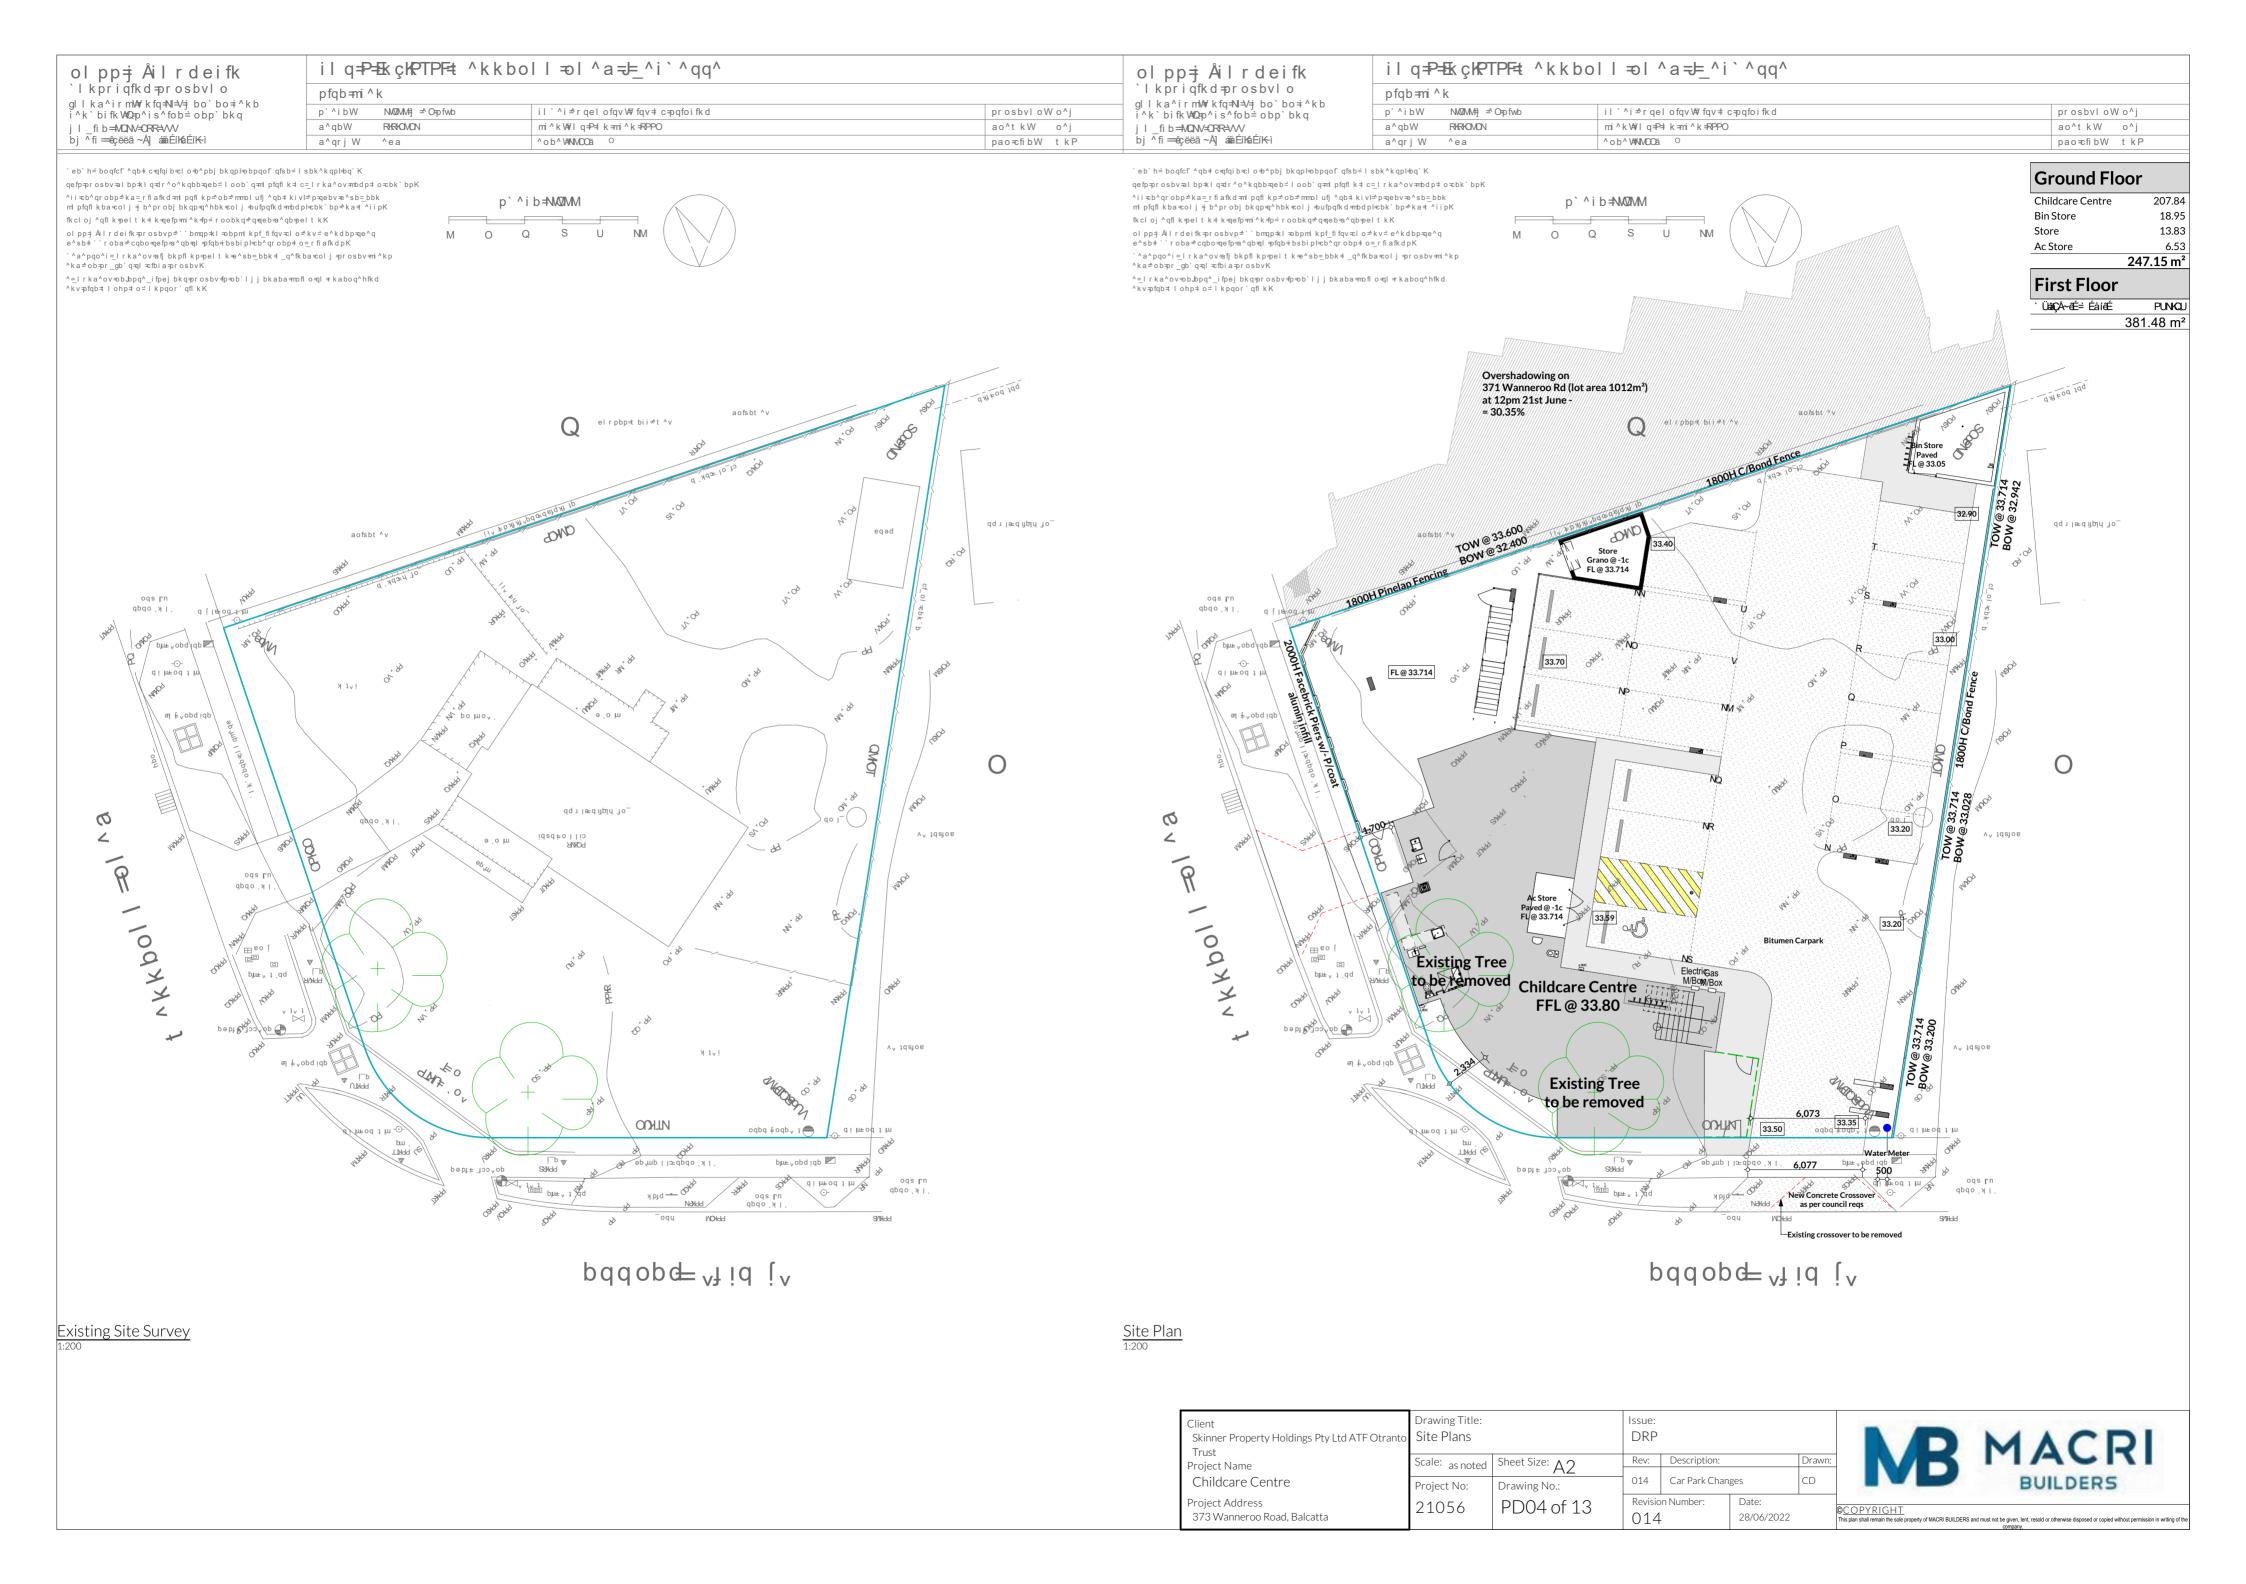

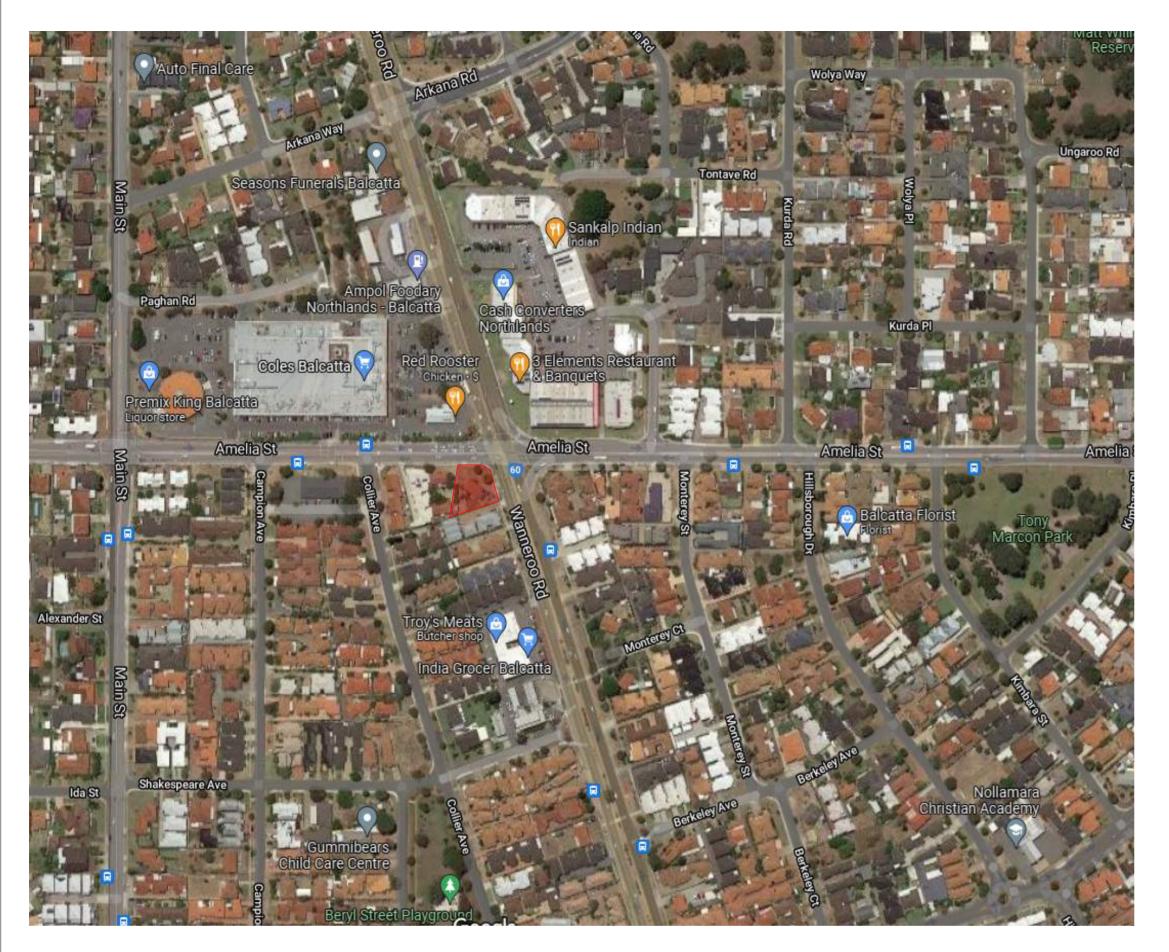











	_					
Client Skinner Property Holdings Pty Ltd ATF Otranto Trust	Drawing Title: Context Plan			Issue: DRP		
Project Name	Scale: as noted	Sheet Size: Δ 2	Rev:	Description:		
Childcare Centre	Project No:	/ _		Car Park Chan	ges	
Project Address 373 Wanneroo Road, Balcatta	21056	PD05 of 13	Revision 014	n Number:	Date: 28/06/202	









Project Address 373 Wanneroo Road, Balcatta Revision Number:

014

Date:

28/06/2022

©COPYRIGHT
This plan shall remain the sole property of MACRI BUILDERS and must not be given, lent, resold or otherwise disposed or copied without permission in writing of the

PD08 of 13

21056



Project Address 373 Wanneroo Road, Balcatta Revision Number:

014


Date:

28/06/2022

©COPYRIGHT
This plan shall remain the sole property of MACRI BUILDERS and must not be given, lent, resold or otherwise disposed or copied without permission in writing of the

PD09 of 13

21056

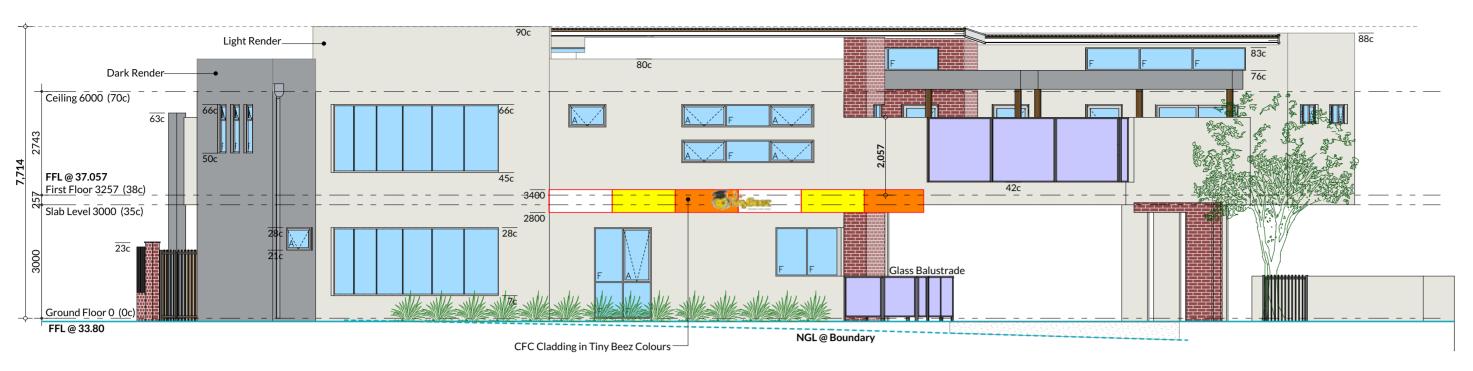


1 North Elevation




Client
Skinner Property Holdings Pty Ltd ATF Otranto
Trust
Project Name
Childcare Centre
Project Address
373 Wanneroo Road, Balcatta

	Drawing Title:	Issue:				Ī		
)	Elevations		DRP					
	Scale: as noted	noted Sheet Size: A2		Description:	Drawn:			
	Project No:	Drawing No.:	014 Car Park Chang Revision Number: 014		ges	CD		
	21056	PD10 of 13			Date:		0	
		. 2 23 31 20			28/06/2022		T	



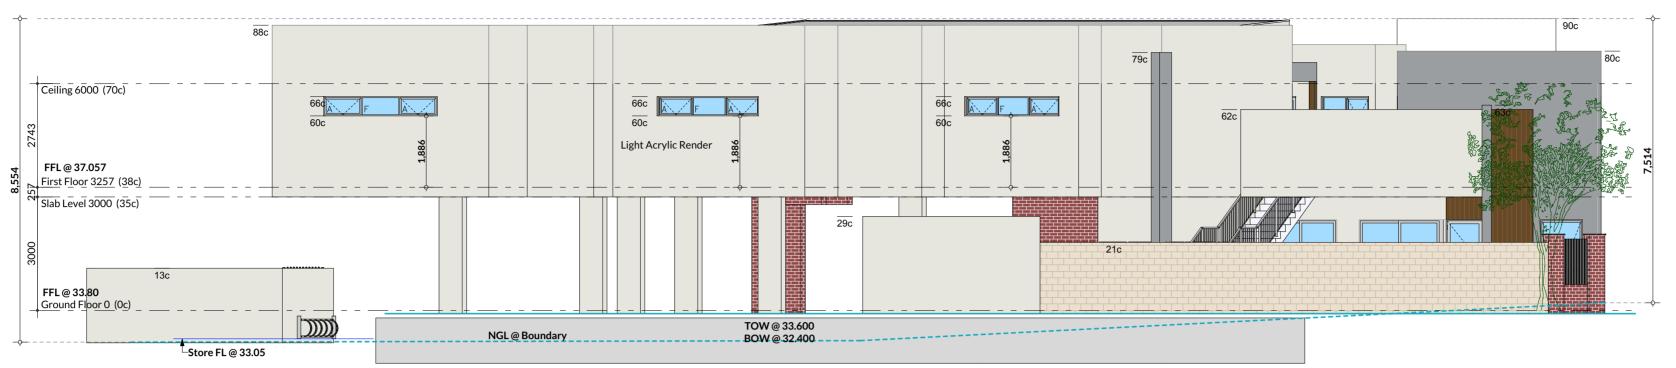


 $\frac{3 South Elevation}{{}_{1:100}}$

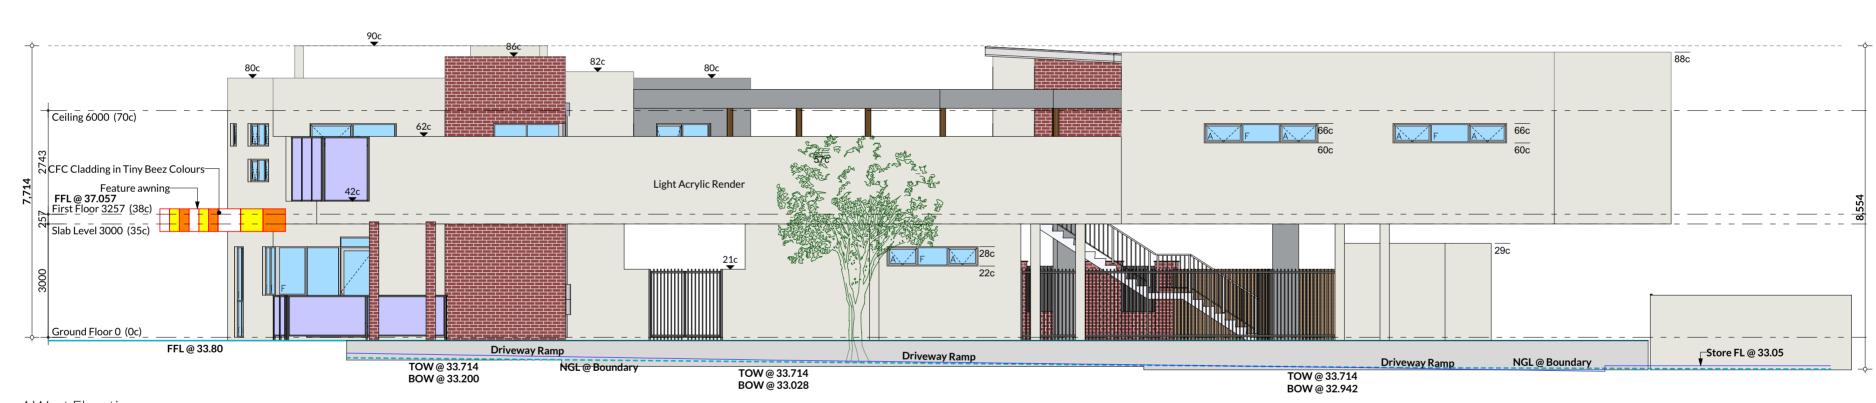

4 West Elevation
1:100

Client Skinner Property Holdings Pty Ltd ATF Otranto	Drawing Title: Elevations			Issue: DRP				
Trust Project Name Childcare Centre	Scale: as noted Project No:	Sheet Size: A2 Drawing No.:	Rev: 014	Description: Car Park Changes		Dra CD		
Project Address 373 Wanneroo Road, Balcatta	21056	PD11 of 13	Revision Number: 014		Date: 28/06/2022			



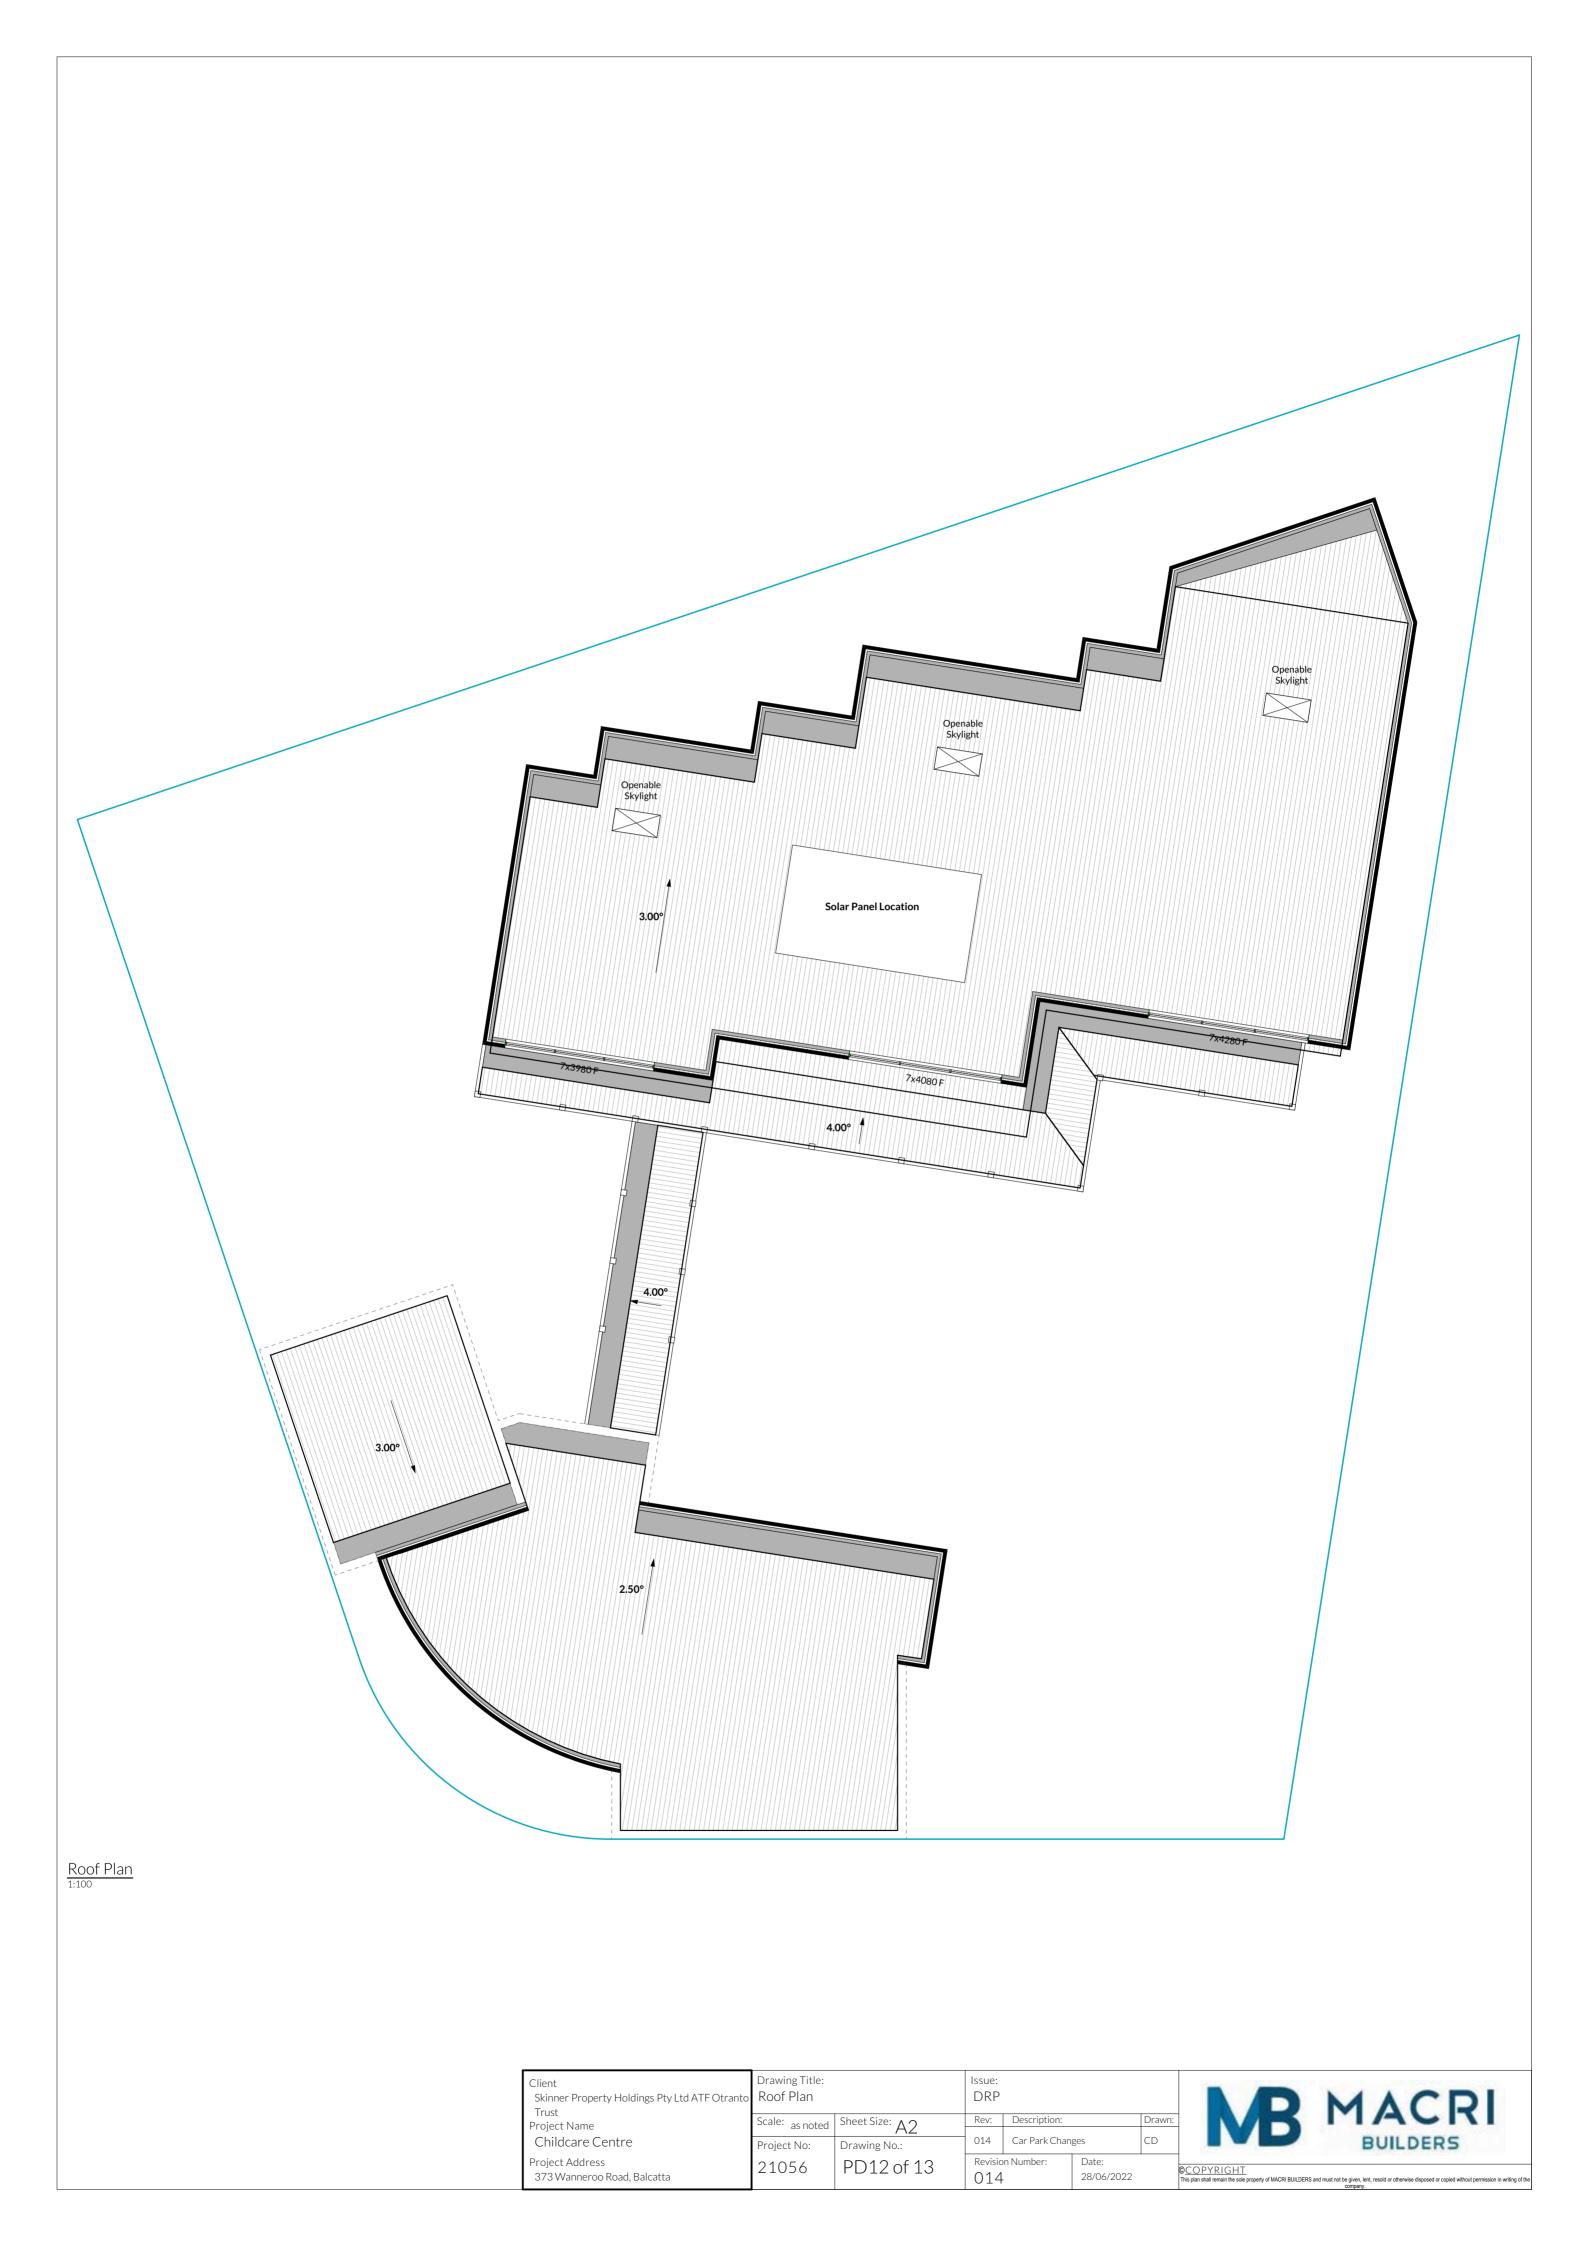

373 WANNEROO ROAD BALCATTA CHILDCARE CENTRE

LANDSCAPE CONCEPT PLANS
JUNE 2022



GROUND FLOOR CONCEPT

LEGEND

- 01) PROPOSED NATIVE STYLE PLANTING TO CAR PARK
- 02 PROPOSED SMALL/MEDIUM TREES TO CAR PARK
- PROPOSED ADVANCED TREES IN STRATACELL (MIN 9M2) 03
- PROPOSED SCREENING TREES ALONG BOUNDARY ADJACENT TO PROPERTY
- LOW NATIVE GROUNDCOVER PLANTING TO CAR PARK EDGE
- PROPOSED ENTRY PAVEMENT EXPOSED AGGREGATE
- PROPOSED 'PLANTING TO SITE BOUNDARY TO BORDER EXISTING FOOTPATH
- PROPOSED VERANDAH PAVING COLOURED CONCRETE
- PROPOSED SENSORY PATH WITH COBBLESTONE; TIMBER & PEBBLE INLAYS
- PROPOSED SENSORY GARDEN WITH TEE-PEE CUBBY & PLAY PANELS
- PROPOSED SANDPIT WITH LIMESTONE EDGE & BEACH ENTRY
- PROPOSED SYNTHETIC TURF FOR MOVABLE EQUIPMENT
- 13 PROPOSED GARDEN BED WITH SENSORY PLANTING
- 14) PROPOSED BUILDING OVERHANG
- 15 EXISTING FOOTPATH TO BE RETAINED

SOFT LANDSCAPE

- ADVANCED TREES: HYMENOSPORUM FLAVUM @ 500L POTS
- SCREENING TREES: MAGNOLIA LITTLE GEM @ 100L POTS SMALL MEDIUM TREES: EUCALYPTUS FORRESTIANA @ 200L POTS

SOFT LANDSCAPE (GROUND FLOOR) 108M2 10.5%

NOTE: ALL GARDEN BEDS AND TREES (INCL FIRST FLOOR PLANTERS) TO BE IRRIGATED



373 WANNEROO ROAD, BALCATTA CHILDCARE CENTRE

FIRST FLOOR CONCEPT



LEGEND

01) PROPOSED COMPOSITE DECKING ON STILTS

PROPOSED SYNTHETIC TURF SOFTFALL WITH SPACE FOR MOVEABLE EQUIPMENT

PROPOSED RAISED SANDPIT WITH TIMBER EDGE 03 AND STAIRS

PROPOSED BIKE TRACK WITH TACTILE PAVING INLAYS (I.E. COBBLESTONE; UNIT PAVING; TIMBER

05) PROPOSED SYNTHETIC TURF MOUNDING

PROPOSED 'HIDDEN' DECK AREA WITH HIDEY HOLE PLAY ITEM

PROPOSED PLAY DECK WITH ARBOR STRUCTURE WITH CLIMBING PLANTS

PROPOSED PLAY FORT STRUCTURE WITH CLIMBING NET & SLIDE

09 PROPOSED PLAY PANEL - CHALKBOARD

PROPOSED QUIET AREA -SYNTHETIC TURF WITH CIRCULAR STEPPING STONES; CUBBY WITH PLAY PANELS & FRUIT TREES IN RAISED PLANTERS

PROPOSED PLAY PANEL - MIRROR

PROPOSED MUD PLAY KITCHEN

PROPOSED RAISED CIRCULAR PLANTERS WITH SMALL FEATURE TREES AND SENSORY PLANTING

PROPOSED RAISED STEEL CLAD PLANTERS WITH SENSORY PLANTING

PROPOSED SHADE SAIL OVER PLAY STRUCTURE & SANDPIT

PROPOSED BUILDING VERANDAH/ WALKWAY


IMAGERY - GROUND FLOOR









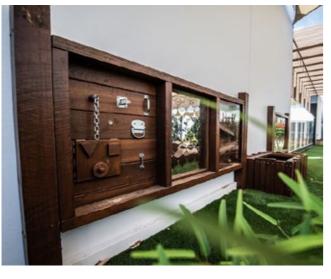















373 WANNEROO ROAD, BALCATTA CHILDCARE CENTRE



IMAGERY - FIRST FLOOR



























373 WANNEROO ROAD, BALCATTA CHILDCARE CENTRE



PLANTING PALETTE

EXTERNAL





























EREMOPHILA KALBARRI CARPET

OLEARIA AXILLARIS

LOMANDRA VERDAY

CONOSTYLIS CANDICANS



PLANTING - INTERNAL (PLAY SPACES)













CONOSTYLIS CANDICANS





























CHRYSANTHEMUM SNOWLAND

LAURUS NOBILIS

VIOLA HEDERACEA

OTHONNA RUBY NECKLACE

DICHONDRA SILVER FALLS

COPYRIGHT THIS DOCUMENT IS AND SHALL REMAIN THE PROPERTY OF PLAN E

REV C